

NOTES:

GENERAL PLANTING REQUIREMENTS

ALL SIZES SHOWN FOR PLANT MATERIAL ON THE PLANS ARE TO BE CONSIDERED MINIMUM. ALL PLANT MATERIAL MUST MEET OR EXCEED THESE MINIMUM REQUIREMENTS FOR BOTH HEIGHT AND SPREAD. ANY OTHER REQUIREMENTS FOR SPECIFIC SHAPE OR EFFECT AS NOTED ON THE PLAN(S) WILL ALSO BE REQUIRED FOR FINAL ACCEPTANCE.

ALL PLANT MATERIAL FURNISHED BY THE LANDSCAPE CONTRACTOR SHALL BE FLORIDA \*\*1 OR BETTER AS ESTABLISHED BY "GRADES AND STANDARDS FOR FLORIDA NURSERY PLANTS" AND "GRADES AND STANDARDS FOR FLORIDA NURSERY TREES". ALL MATERIAL SHALL BE INSTALLED AS PER CSI SPECIFICATIONS.

ALL PLANT MATERIAL AS INCLUDED HEREIN SHALL BE WARRANTIED BY THE LANDSCAPE CONTRACTOR FOR A MINIMUM PERIOD AS FOLLOWS: ALL TREES AND PALMS FOR 12 MONTHS, ALL SHRUBS, VINES, GROUNDCOVERS AND MISCELLANEOUS PLANTING MATERIALS FOR 90 DAYS, AND ALL LAWN AREAS FOR 60 DAYS AFTER FINAL ACCEPTANCE BY THE OWNER

ALL PLANT MATERIAL SHALL BE PLANTED IN PLANTING SOIL THAT IS DELIVERED TO THE SITE IN A CLEAN LOOSE AND FRIABLE CONDITION. ALL SOIL SHALL HAVE A WELL DRAINED CHARACTERISTIC. SOIL MUST BE FREE OF ALL ROCKS, STICKS, AND OBJECTIONABLE MATERIAL INCLUDING WEEDS AND WEED SEEDS AS PER CSI SPECIFICATIONS.

TWELVE INCHES (12") OF PLANTING SOIL 50/50 SAND/TOPSOIL MIX IS REQUIRED AROUND AND BENEATH THE ROOT BALL OF ALL TREES AND PALMS, AND 1 CUBIC YARD PER 50 BEDDING OR GROUNDCOVER PLANTS.

ALL LANDSCAPE AREAS SHALL BE COVERED WITH EUCALYPTUS OR STERILIZED SEED FREE MELALEUCA MULCH TO A MINIMUM DEPTH OF THREE INCHES (3") OF COVER WHEN SETTLED. CYPRESS BARK MULCH SHALL NOT BE USED.

ALL PLANT MATERIAL SHALL BE THOROUGHLY WATERED IN AT THE TIME OF PLANTING; NO DRY PLANTING PERMITTED. ALL PLANT MATERIALS SHALL BE PLANTED SUCH THAT THE TOP OF THE PLANT BALL IS FLUSH WITH THE SURROUNDING GRADE.

IT IS THE SOLE RESPONSIBILITY OF THE LANDSCAPE CONTRACTOR TO INSURE THAT ALL NEW PLANTINGS RECEIVE ADEQUATE WATER DURING THE INSTALLATION AND DURING ALL PLANT WARRANTY PERIODS. DEEP WATERING OF ALL NEW TREES AND PALMS AND ANY SUPPLEMENTAL WATERING THAT MAY BE REQUIRED TO AUGMENT NATURAL RAINFALL AND SITE IRRIGATION IS MANDATORY TO INSURE PROPER PLANT DEVELOPMENT AND SHALL BE PROVIDED AS A PART OF THIS CONTRACT.

ALL PLANT MATERIAL SHALL BE INSTALLED WITH FERTILIZER, WHICH SHALL BE STATE APPROVED AS A COMPLETE FERTILIZER CONTAINING THE REQUIRED MINIMUM OF TRACE ELEMENTS IN ADDITION TO N-P-K, OF WHICH 50% OF THE NITROGEN SHALL BE DERIVED FROM AN ORGANIC

CONTRACTORS ARE RESPONSIBLE FOR COORDINATING WITH THE OWNERS AND APPROPRIATE PUBLIC AGENCIES TO ASSIST IN LOCATING AND VERIFYING ALL UNDERGROUND UTILITIES

THE PLAN TAKES PRECEDENCE OVER THE PLANT LIST.

SPECIAL INSTRUCTIONS GENERAL SITE AND BERM GRADING TO +/- 1 INCH (1") SHALL BE PROVIDED BY THE GENERAL CONTRACTOR. ALL FINISHED SITE GRADING AND FINAL DECORATIVE BERM SHAPING SHALL BE PROVIDED BY THE LANDSCAPE CONTRACTOR.

ALL LANDSCAPED OPEN AREAS TO RECEIVE BAHIA GRASS THROUGHOUT (WHERE INDICATED ON THE PLANS). ALL TREES SHALL BE PROPERLY GUYED AND STAKED.

IF ANY LANDSCAPE AREAS ON ADJACENT PROPERTIES ARE DISTURBED BY THE NEW CONSTRUCTION. THEY WILL BE RETURNED TO THEIR ORIGINAL CONDITIONS PRIOR TO C.O.

LANDSCAPE LEGEND INFORMATION REQUIRED TO BE PERMANENTLY AFFIXED\_TO PLAN NET LOT AREA 0.77 ACRES 33,331 S.F. ZONING DISTRICT: BU-3

<u>PROVIDED</u>

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A. SQUARE FEET OF OPEN SPACE REQUIRED BY CHAPTER 33, AS INDICATED ON SITE PLAN: 6,624 S.F. 6,000 S.F. NET LOT AREA = 33,331 S.F. X 18 %= 6,000 S.F. B. SQUARE FEET OF PARKING LOT OPEN SPACE REQUIRED BY CHAPTER 18A, AS INDICATED ON SITE PLAN: \_\_\_\_302 S.F. 200 S.F. NO. PARKING SPACES 20 X 10 S.F. PER PARKING SPACE = 6,200 S.F. 6,926 S.F. C. TOTAL S.F. OF LANDSCAPED OPEN SPACE REQUIRED BY CHAPTER 33: A+B =

LAWN AREA CALCULATION A. 6,200 TOTAL S.F. OF LANDSCAPED OPEN SPACE REQUIRED BY CHAPTER 33 B. MAXIMUM LAWN AREA (SOD) PERMITTED = 20% X 6,200 S.F. =

TREES
A. NO. TREES REQUIRED PER NET LOT ACRE LESS EXISTING NUMBER OF TREES MEETING MINIMUM REQUIREMENTS 

OPEN SPACE

B. % PALMS ALLOWED: NO. TREES PROVIDED X 30% = % PALMS PERMITTED TO COUNT AS STREET TREES ON 1:1 BASIS X 30%

C. % NATIVES REQUIRED: NO. TREES PROVIDED X 30% = D. STREET TREES (MAXIMUM AVERAGE SPACING OF 35' O.C.): 520 LINEAR FEET ALONG STREET / 35 =

E. STREET TREES LOCATED DIRECTLY BENEATH POWER LINES (MAXIMUM AVERAGE SPACING OF 25' O.C.):\_\_\_\_LINEAR FEET ALONG STREET / 25 = A. NO. TREES REQUIRED X 10 = NO. OF SHRUBS ALLOWED


B. NO. SHRUBS ALLOWED X 30% = NO. OF NATIVE SHRUBS REQUIRED


IRRIGATION PLAN: IF REQUIRED BY CHAPTER 33 TABLE: CONTAINING INFORMATION AS INDICATED IN SAMPLE BELOW:

SYMBOL USED ON PLAN			PLANT NAME		NATIVE SPECIES		CALIPER	HEIG	GHT	CANOPY DIAMETER	QUANTITTY
Symbol	New	Existing	Scientific	Common	Yes	No	Installed	Installed	Estimated at Maturity*	Estimated at Maturity*	
J. S. S. S.	Yes	-	Quercus laurifolia	Live Oak	Yes	-	2"	12′	40′ - 50′	35'	155
$\overline{\odot}$	Yes	-	Swietenia mahagoni	Mahogany	-	No	2"	10'	35′ - 60′	25′	77
	Yes	_	Bursera simaruba	Gumbo Limbo	Yes	-	1 1/2"	8′	40 - 60'	20'	Æ
*	Yes	-	Thrinax parviflora	Broom Thatch Palm		No	3"	10′	15' - 20'	20'	Æ
***************************************	Yes	_	Pittosporum tobira	Pittosporum		No	N/A	2' - 3'	6' - 8'	4'	1110
**	Yes	-	Croton linearis	Pineland Croton	Yes	-	N/A	2' - 3'	3' - 6'	3′	55

SCIENTIFIC NAME	COMMON NAVE	DROUGHT TOLERANCE	SALT TOLERANCE	NATIVE COMMUNITY		HEIGHT			ESTABLISHMENT	WEAR TOLERANCE	TURF DENSITY	TURF TEXTURE	MA INTE:NANCE		NOT LAWN SUITABLE
	BAHIA GRASS	X	NO	NO	20"		3-4"	HIGH	SEED,SOD	GOOD	LOW	MEDIUM	LOW	LOW	N/A

\*REQUIRED FOR TREES LOCATED UNDERNEATH OR ADJACENT TO POWERLINES AND PALMS USED AT 1:1 RATIO
ADDITIONAL INFORMATION REQUIRED BY CHAPTER 18A FOR BUSINESS AND INDUSTRIAL ZONES
\*\*EXCLUDED LAWN AREA AS PROVIDED IN CHAPTER 18A SHALL BE SUBTRACTED FROM NET LAWN AREA WHEN CALCULATING NUMBER OF TREES

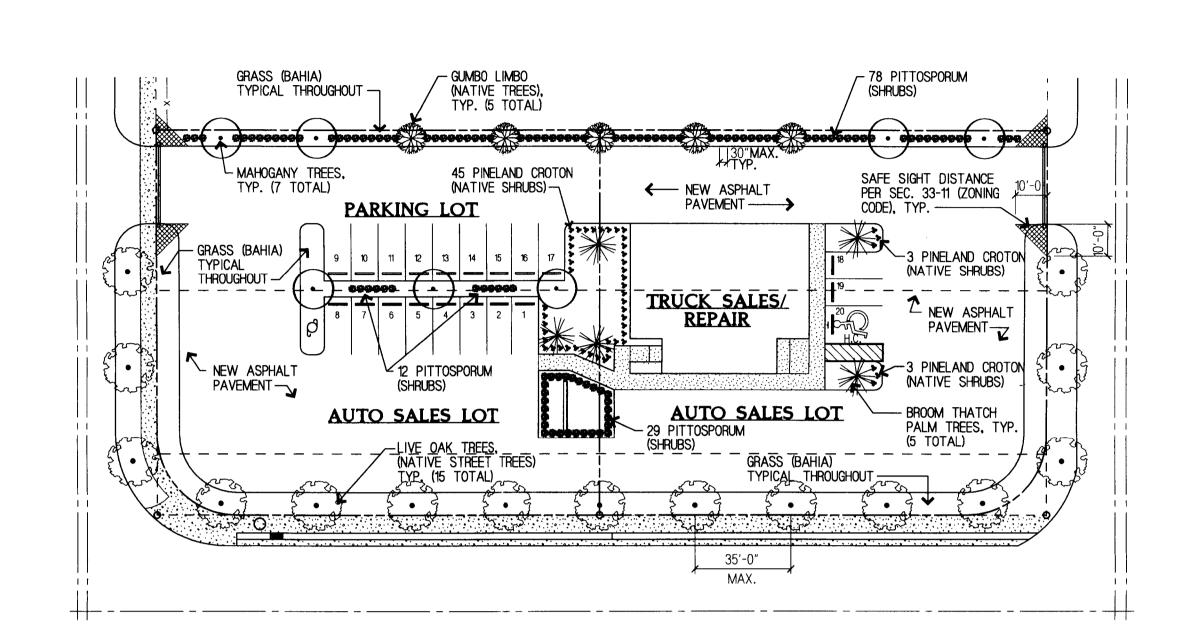

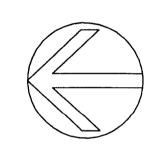

SCALE: 1"= 30'

## LANDSCAPING PLAN LEGEND AND NOTES

N.T.S. LANDSCAPING PLAN


- 2X4" WOOD BRACES NAILED INTO THE WOOD BATTENS 3" MULCH LAYER BANDING WIRE —— AROUND 5 LAYERS BURLAP (MIN.) 5-6" WATER

--- 5 LAYERS BURLAP (MIN.) - 2X4" WOOD BRACES NAILED INTO THE WOOD BATTENS - 3" MUCH LAYER 5-6" WATER RING


LARGE TREE PLANTING DITAIL


\* Switch


KEY PLAN

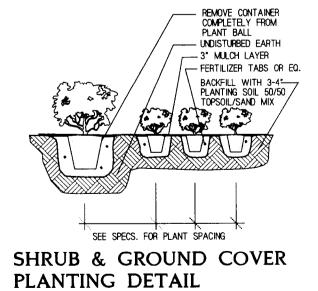

ARCHITECT

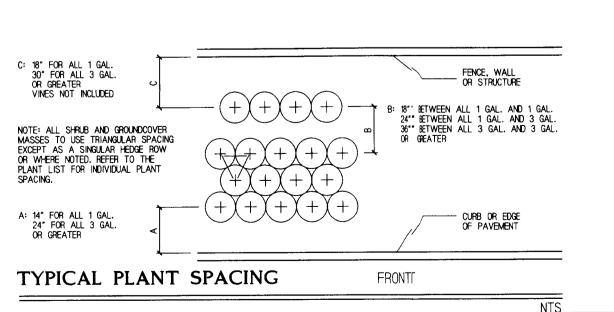


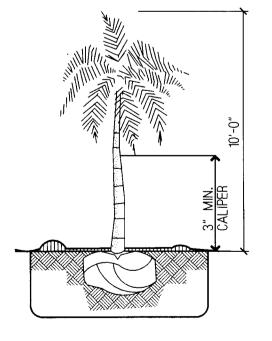

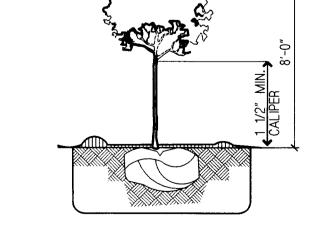


NATIVE TREE HEIGHT

NO. DATE DESCRIPTION

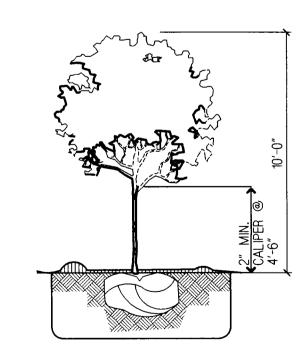

APPRV SEAL

LOT TREE HEIGHT

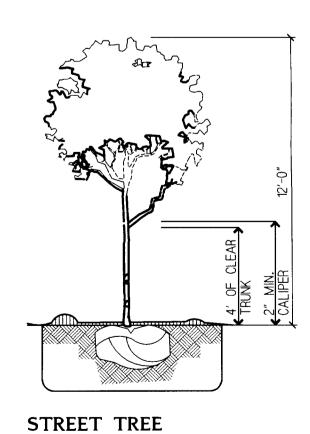

DRAWING TITLE

TRUCK SALES

PALM PLANTING DETAIL

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Offerle-Lerner, AIA

13831 SW 59 ST SUITE 200, MIAMI, FL 33183 305-385-1700 AA#0003139

PALM TREE HEIGHT

02/24/04 NOT FOR CONSTRUCTION CADD RELEASED FOR CONSTRUCTION

AS-BUILT DRAWING

MAR 2 4 2004 AR#0005784

LANDSCAPE PLAN DRAWING NO. ARCHITECT'S PRJ. NO. 04-005

OF MIAMI

PROJECT TITLE TRUCK SALES OF MIAMI

6501 NW 27TH AVE MIAMI, FLORIDA 33147 DRAWN BY CHECKED BY ADL RECORD DRAWING APPROVED BY

alan d. L<del>erne</del>r

SHEET = OF -

